

## Appendix A: Maps and Construction Typicals

Attachment A: Project Route Maps and Plans Provided under Separate Cover


On August 10, 2009, Ruby filed with FERC a set of revised 7.5-minute USGS topographic maps showing the most recent alignment for the proposed Ruby Pipeline Project. The updated topographic maps reflected the 3 alternatives and 15 minor route variations recommended by FERC in the Draft Environmental Impact Statement.

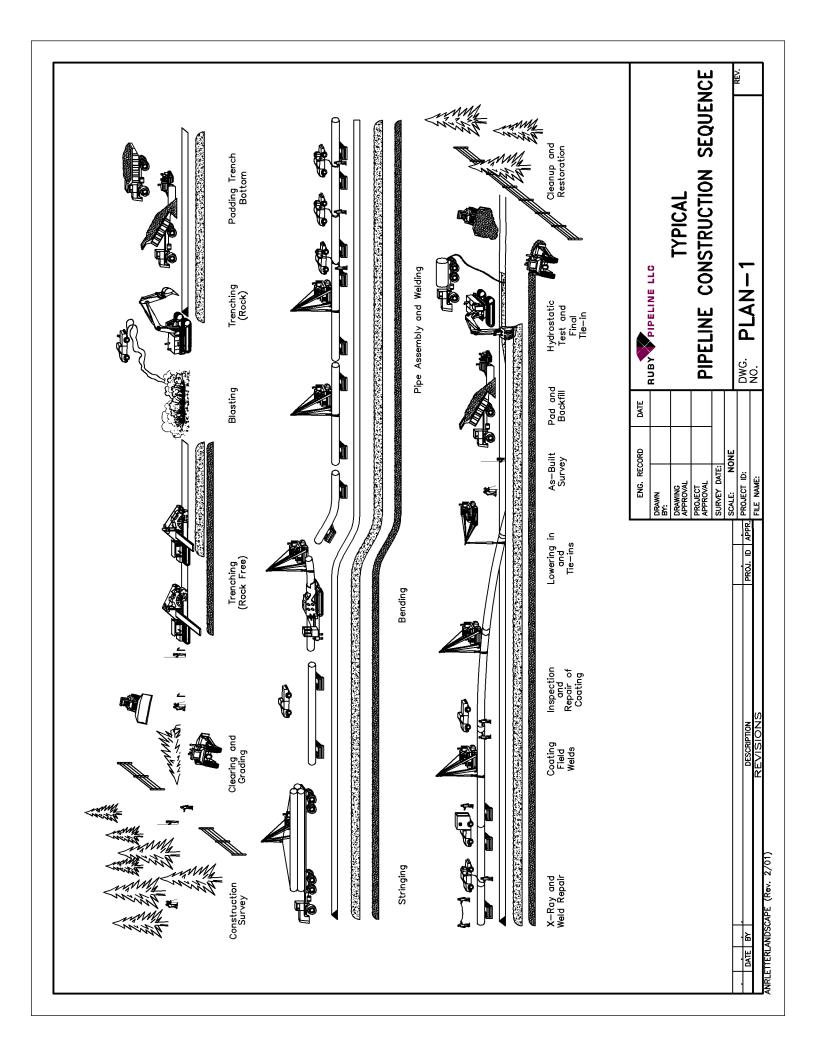

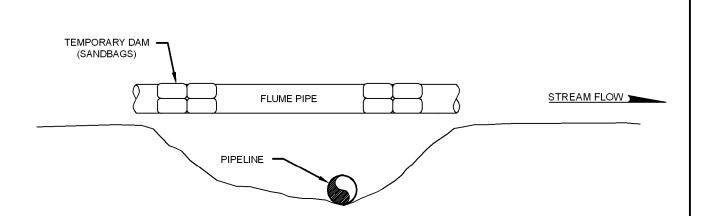


- 1. THE REQUIRED SET BACK FOR ADDITIONAL WIDTH WORK SPACE IS 50 FEET FROM TOP OF BANK UNLESS APPROVED OTHERWISE BY THE APPROPRIATE AGENCIES.
- 2. A 10' VEGETATION BUFFER WILL BE MAINTAINED BETWEEN THE BANK AND TWS.
- 3. THE MINIMUM REQUIRED SETBACK FOR SPOIL PILE IS 10 FEET FROM THE TOP OF BANK.
- 4. EQUIPMENT BRIDGE SHALL REMAIN IN PLACE UNTIL THE COMPLETION OF FINAL RESTORATION.
- 5. WEED-FREE STRAW BALES, SAND BAGS, DRIVABLE BERMS OR OTHER APPROPRIATE EROSION CONTROL MAY BE USED INTERCHANGEABLY AT THE EDGE OF EQUIPMENT BRIDGE.

					ENG. RECORD		DATE	RUBY PIPELINE LLC
					DRAWN BY:			·
					DRAWING APPROVAL			TYPICAL
					PROJECT APPROVAL			DRY WATERBODY CROSSING
					SURVEY DATE:			(METHOD 2A - FLUMED)
					SCALE: NONE			
NO I	DATE	BY	DESCRIPTION	PROJ. ID APPR.	PROJECT ID:		·	DWG. PLAN-11
			REVISIONS		FILE NAME:			NO.
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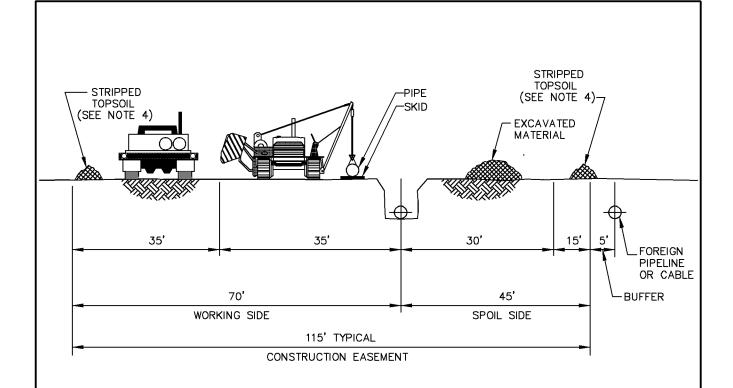
## CROSS-SECTION OF PIPELINE CONSTRUCTION RIGHT-OF-WAY OPEN FLAT COUNTRY

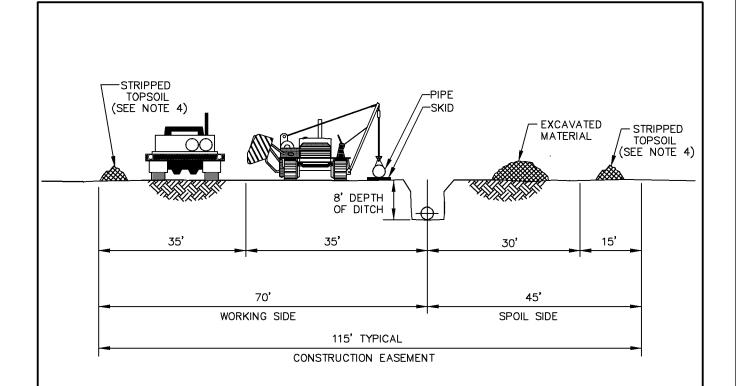- 1. CONSTRUCTION RIGHT-OF-WAY WILL TYPICALLY BE 115 FEET WIDE. THE PERMANENT RIGHT-OF-WAY WILL BE 50 FEET WIDE CENTERED ON PIPE. AS REQUIRED, ADDITIONAL TEMPORARY WORKSPACE WILL BE NECESSARY AT MAJOR ROAD, RAIL, RIVER CROSSINGS, SIDESLOPES, WHERE FULL RIGHT-OF-WAY TOPSOIL STRIPPING IS CONDUCTED AND OTHER SPECIAL CIRCUMSTANCES.
- 2. TOPSOIL IS TO BE STRIPPED OVER THE DITCH AND SPOIL SIDE EXCEPT AS NOTED BELOW.
- 3. TOPSOIL IS TO BE STRIPPED ACROSS THE ENTIRE RIGHT-OF-WAY WHEN GRADING IS REQUIRED, IN NOXIOUS WEED AREAS, AT LANDOWNER REQUEST AND/OR AS REQUIRED BY THE ENVIRONMENTAL INSPECTOR.
- 4. TOPSOIL IS TO BE SEGREGATED AND STOCKPILED ON THE OUTSIDE EDGE OF THE RIGHT-OF-WAY.
- 5. IN ACCORDANCE WITH RUBY'S UPLAND CONTROL, REVEGETATION AND MAINTENANCE PLAN AND WITH LANDOWNER APPROVAL, A 25 FOOT WIDE AREA ADJACENT TO THE WORKING SIDE OF THE RIGHT—OF—WAY THAT IS TO REMAIN UNDISTURBED WILL BE UTILIZED FOR TEMPORARY SLASH AND TIMBER STORAGE. SNOW MAY ALSO BE PLACED IN THIS AREA.




# CROSS-SECTION OF PIPELINE CONSTRUCTION RIGHT-OF-WAY - WORKING SIDE ADJACENT TO PIPELINE OR CABLE (50' C/L TO C/L)

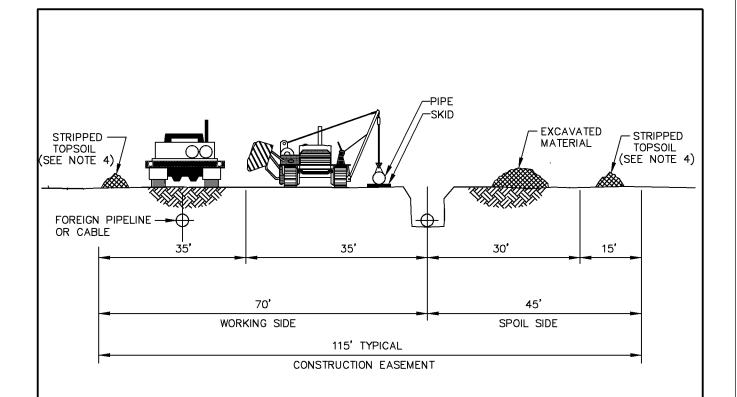- 1. CONSTRUCTION RIGHT-OF-WAY WILL TYPICALLY BE 115 FEET WIDE. THE PERMANENT RIGHT-OF-WAY WILL BE 50 FEET WIDE CENTERED ON PIPE. AS REQUIRED, ADDITIONAL TEMPORARY WORKSPACE WILL BE NECESSARY AT MAJOR ROAD, RAIL, RIVER CROSSINGS, SIDESLOPES, WHERE FULL RIGHT-OF-WAY TOPSOIL STRIPPING IS CONDUCTED AND OTHER SPECIAL CIRCUMSTANCES.
- 2. TOPSOIL IS TO BE STRIPPED OVER THE DITCH AND SPOIL SIDE EXCEPT AS NOTED BELOW.
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- 4. TOPSOIL IS TO BE SEGREGATED AND STOCKPILED ON THE OUTSIDE EDGE OF THE RIGHT-OF-WAY.
- 5. IN ACCORDANCE WITH RUBY'S UPLAND CONTROL, REVEGETATION AND MAINTENANCE PLAN AND WITH LANDOWNER APPROVAL, A 25 FOOT WIDE AREA ADJACENT TO THE WORKING SIDE OF THE RIGHT—OF—WAY THAT IS TO REMAIN UNDISTURBED WILL BE UTILIZED FOR TEMPORARY SLASH AND TIMBER STORAGE. SNOW MAY ALSO BE PLACED IN THIS AREA.



# CROSS-SECTION OF PIPELINE CONSTRUCTION RIGHT-OF-WAY - SPOIL SIDE ADJACENT TO PIPELINE OR CABLE (50' C/L TO C/L)


- 1. CONSTRUCTION RIGHT-OF-WAY WILL TYPICALLY BE 115 FEET WIDE. THE PERMANENT RIGHT-OF-WAY WILL BE 50 FEET WIDE CENTERED ON PIPE. AS REQUIRED, ADDITIONAL TEMPORARY WORKSPACE WILL BE NECESSARY AT MAJOR ROAD, RAIL, RIVER CROSSINGS, SIDESLOPES, WHERE FULL RIGHT-OF-WAY TOPSOIL STRIPPING IS CONDUCTED AND OTHER SPECIAL CIRCUMSTANCES.
- 2. TOPSOIL IS TO BE STRIPPED OVER THE DITCH AND SPOIL SIDE EXCEPT AS NOTED BELOW.
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- 4. TOPSOIL IS TO BE SEGREGATED AND STOCKPILED ON THE OUTSIDE EDGE OF THE RIGHT-OF-WAY.
- 5. IN ACCORDANCE WITH RUBY'S UPLAND CONTROL, REVEGETATION AND MAINTENANCE PLAN AND WITH LANDOWNER APPROVAL, A 25 FOOT WIDE AREA ADJACENT TO THE WORKING SIDE OF THE RIGHT-OF-WAY THAT IS TO REMAIN UNDISTURBED WILL BE UTILIZED FOR TEMPORARY SLASH AND TIMBER STORAGE. SNOW MAY ALSO BE PLACED IN THIS AREA.

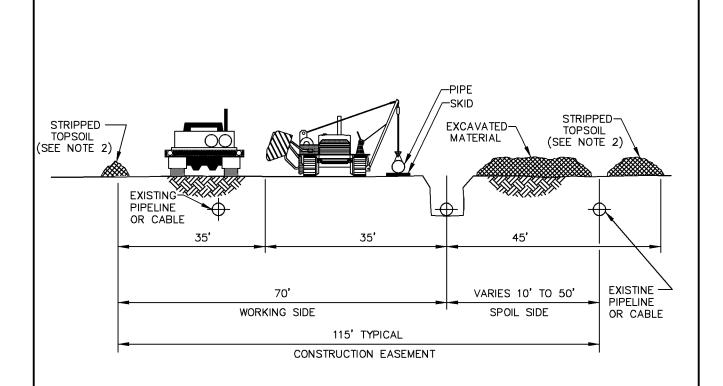

### CROSS-SECTION OF PIPELINE CONSTRUCTION RIGHT-OF-WAY


## SPOIL SIDE — ADJACENT TO PIPELINE OR CABLE WORKING SIDE — OVER EXISTING PIPELINE OR CABLE

- 1. CONSTRUCTION RIGHT-OF-WAY WILL TYPICALLY BE 115 FEET WIDE. THE PERMANENT RIGHT-OF-WAY WILL BE 50 FEET WIDE CENTERED ON PIPE. AS REQUIRED, ADDITIONAL TEMPORARY WORKSPACE WILL BE NECESSARY AT MAJOR ROAD, RAIL, RIVER CROSSINGS, SIDESLOPES, WHERE FULL RIGHT-OF-WAY TOPSOIL STRIPPING IS CONDUCTED AND OTHER SPECIAL CIRCUMSTANCES.
- 2. TOPSOIL IS TO BE STRIPPED OVER THE DITCH AND SPOIL SIDE EXCEPT AS NOTED BELOW.
- 3. TOPSOIL IS TO BE STRIPPED ACROSS THE ENTIRE RIGHT-OF-WAY WHEN GRADING IS REQUIRED, IN NOXIOUS WEED AREAS, AT LANDOWNER REQUEST AND/OR AS REQUIRED BY THE ENVIRONMENTAL INSPECTOR.
- 4. TOPSOIL IS TO BE SEGREGATED AND STOCKPILED ON THE OUTSIDE EDGE OF THE RIGHT-OF-WAY.
- 5. IN ACCORDANCE WITH RUBY'S UPLAND CONTROL, REVEGETATION AND MAINTENANCE PLAN AND WITH LANDOWNER APPROVAL, A 25 FOOT WIDE AREA ADJACENT TO THE WORKING SIDE OF THE RIGHT-OF-WAY THAT IS TO REMAIN UNDISTURBED WILL BE UTILIZED FOR TEMPORARY SLASH AND TIMBER STORAGE. SNOW MAY ALSO BE PLACED IN THIS AREA.
- 6. WHERE APPLICABLE, THE OFFSET FROM THE CONSTRUCTION RIGHT-OF-WAY TO AN ACTIVE FOREIGN PIPELINE OR CABLE WILL BE 50 FEET. DISTANCES MAY INCREASE OR DECREASE TO ACCOMODATE SITE SPECIFIC CONSTRUCTION OR ADJACENT PIPELINE/CABLE COMPANY REQUIREMENTS. CONSTRUCTION EASEMENT MAY SHIFT AS NECESSARY.
- 7. WORKING OVER OR ADJACENT TO EXISTING PIPELINE OR CABLE REQUIRES PIPELINE OR CABLE OPERATORS APPROVAL.

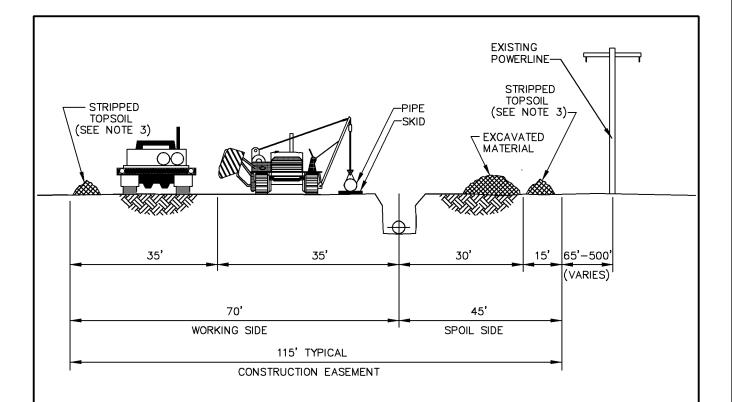


# CROSS-SECTION OF PIPELINE CONSTRUCTION RIGHT-OF-WAY - SPOIL SIDE ADJACENT TO POWERLINE (65'-500' C/L TO C/L)

- 1. CONSTRUCTION RIGHT-OF-WAY WILL TYPICALLY BE 115 FEET WIDE. THE PERMANENT RIGHT-OF-WAY WILL BE 50 FEET WIDE CENTERED ON PIPE. AS REQUIRED, ADDITIONAL TEMPORARY WORKSPACE WILL BE NECESSARY AT MAJOR ROAD, RAIL, RIVER CROSSINGS, SIDESLOPES, WHERE FULL RIGHT-OF-WAY TOPSOIL STRIPPING IS CONDUCTED AND OTHER SPECIAL CIRCUMSTANCES.
- 2. TOPSOIL IS TO BE STRIPPED OVER THE DITCH AND SPOIL SIDE EXCEPT AS NOTED BELOW.
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- 4. TOPSOIL IS TO BE SEGREGATED AND STOCKPILED ON THE OUTSIDE EDGE OF THE RIGHT-OF-WAY.
- 5. IN ACCORDANCE WITH RUBY'S UPLAND CONTROL, REVEGETATION AND MAINTENANCE PLAN AND WITH LANDOWNER APPROVAL, A 25 FOOT WIDE AREA ADJACENT TO THE WORKING SIDE OF THE RIGHT-OF-WAY THAT IS TO REMAIN UNDISTURBED WILL BE UTILIZED FOR TEMPORARY SLASH AND TIMBER STORAGE. SNOW MAY ALSO BE PLACED IN THIS AREA.

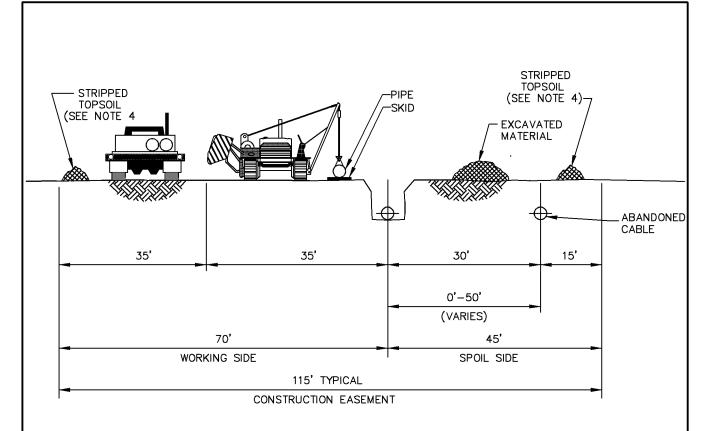


# CROSS-SECTION OF PIPELINE CONSTRUCTION RIGHT-OF-WAY - SPOIL SIDE ADJACENT TO ABANDONED CABLE (0'-50' C/L TO C/L)

- 1. CONSTRUCTION RIGHT-OF-WAY WILL TYPICALLY BE 115 FEET WIDE. THE PERMANENT RIGHT-OF-WAY WILL BE 50 FEET WIDE CENTERED ON PIPE. AS REQUIRED, ADDITIONAL TEMPORARY WORKSPACE WILL BE NECESSARY AT MAJOR ROAD, RAIL, RIVER CROSSINGS, SIDESLOPES, WHERE FULL RIGHT-OF-WAY TOPSOIL STRIPPING IS CONDUCTED AND OTHER SPECIAL CIRCUMSTANCES.
- 2. TOPSOIL IS TO BE STRIPPED OVER THE DITCH AND SPOIL SIDE EXCEPT AS NOTED BELOW.
- 3. TOPSOIL IS TO BE STRIPPED ACROSS THE ENTIRE RIGHT-OF-WAY WHEN GRADING IS REQUIRED, IN NOXIOUS WEED AREAS, AT LANDOWNER REQUEST AND/OR AS REQUIRED BY THE ENVIRONMENTAL INSPECTOR.
- 4. TOPSOIL IS TO BE SEGREGATED AND STOCKPILED ON THE OUTSIDE EDGE OF THE RIGHT-OF-WAY.
- 5. IN ACCORDANCE WITH RUBY'S UPLAND CONTROL, REVEGETATION AND MAINTENANCE PLAN AND WITH LANDOWNER APPROVAL, A 25 FOOT WIDE AREA ADJACENT TO THE WORKING SIDE OF THE RIGHT-OF-WAY THAT IS TO REMAIN UNDISTURBED WILL BE UTILIZED FOR TEMPORARY SLASH AND TIMBER STORAGE. SNOW MAY ALSO BE PLACED IN THIS AREA.
- 6. ABANDONED CABLE TO BE REMOVED FROM DITCHLINE.
- 7. CABLE ACCESS ROAD TO BE ELIMINATED FROM RIGHT-OF-WAY DURING RESTORATION WITH LANDOWNER APPROVAL.

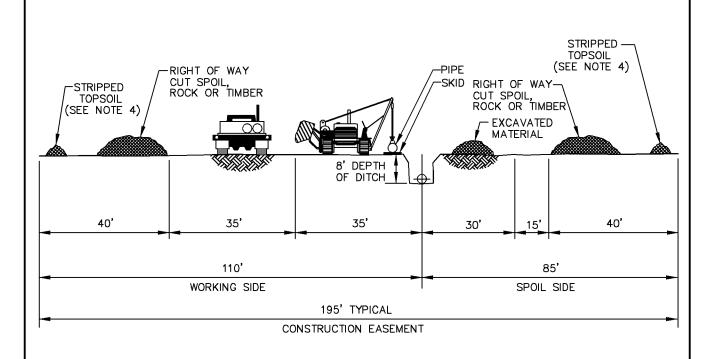

## CROSS-SECTION OF PIPELINE CONSTRUCTION RIGHT-OF-WAY 195' CONSTRUCTION WORK SPACE


- 1. CONSTRUCTION RIGHT-OF-WAY WILL TYPICALLY BE 195 FEET WIDE. THE PERMANENT RIGHT-OF-WAY WILL BE 50 FEET WIDE CENTERED ON PIPE. AS REQUIRED, ADDITIONAL TEMPORARY WORKSPACE WILL BE NECESSARY AT MAJOR ROAD, RAIL, RIVER CROSSINGS, SIDESLOPES, WHERE FULL RIGHT-OF-WAY TOPSOIL STRIPPING IS CONDUCTED AND OTHER SPECIAL CIRCUMSTANCES.
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- 4. TOPSOIL IS TO BE SEGREGATED AND STOCKPILED ON THE OUTSIDE EDGE OF THE RIGHT-OF-WAY.
- 5. IN ACCORDANCE WITH RUBY'S UPLAND CONTROL, REVEGETATION AND MAINTENANCE PLAN AND WITH LANDOWNER APPROVAL, A 25 FOOT WIDE AREA ADJACENT TO THE WORKING SIDE OF THE RIGHT-OF-WAY THAT IS TO REMAIN UNDISTURBED WILL BE UTILIZED FOR TEMPORARY SLASH AND TIMBER STORAGE. SNOW MAY ALSO BE PLACED IN THIS AREA.

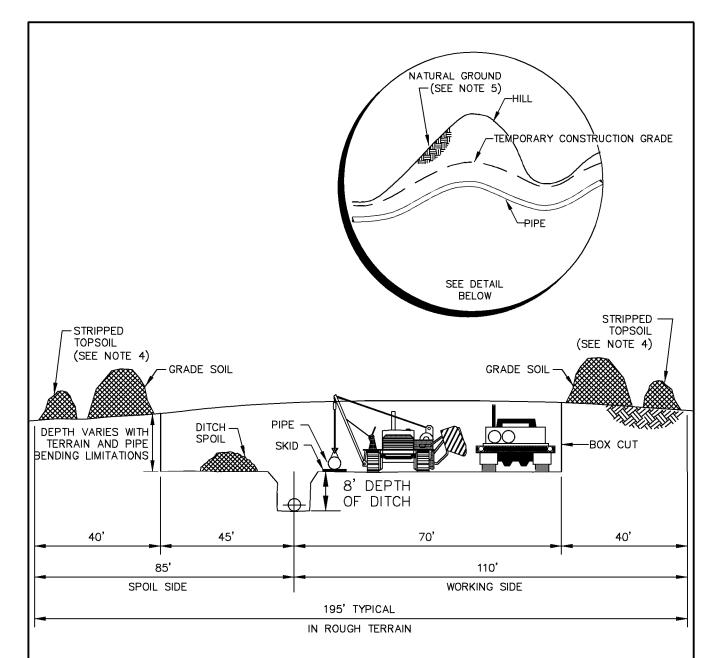

# CROSS-SECTION OF PIPELINE CONSTRUCTION RIGHT-OF-WAY STEEP SLOPE/ROUGH CHOPPY TERRAIN


- 1. CONSTRUCTION RIGHT-OF-WAY WILL TYPICALLY BE 115 FEET WIDE. THE PERMANENT RIGHT-OF-WAY WILL BE 50 FEET WIDE CENTERED ON PIPE. AS REQUIRED, ADDITIONAL TEMPORARY WORKSPACE WILL BE NECESSARY AT MAJOR ROAD, RAIL, RIVER CROSSINGS, SIDESLOPES, WHERE FULL RIGHT-OF-WAY TOPSOIL STRIPPING IS CONDUCTED AND OTHER SPECIAL CIRCUMSTANCES.
- 2. TOPSOIL IS TO BE STRIPPED OVER THE DITCH AND SPOIL SIDE EXCEPT AS NOTED BELOW.
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- 4. TOPSOIL IS TO BE SEGREGATED AND STOCKPILED ON THE OUTSIDE EDGE OF THE RIGHT-OF-WAY.
- 5. GRADE TO BE RESTORED AFTER CONSTRUCTION



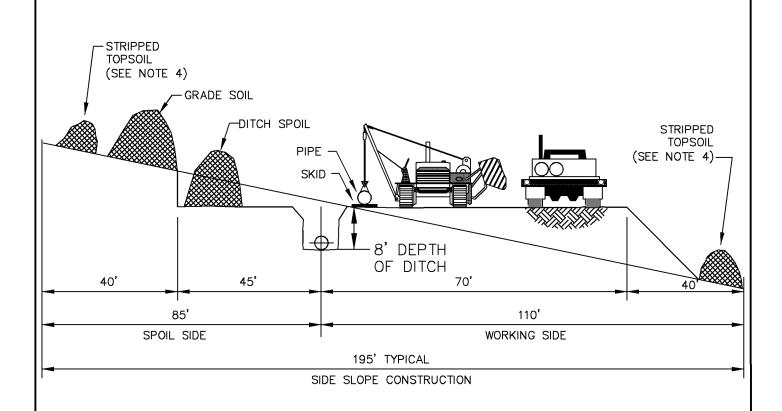


# CROSS-SECTION OF PIPELINE CONSTRUCTION RIGHT-OF-WAY SIDE CUT LEFT

- 1. CONSTRUCTION RIGHT-OF-WAY WILL TYPICALLY BE 115 FEET WIDE. THE PERMANENT RIGHT-OF-WAY WILL BE 50 FEET WIDE CENTERED ON PIPE. AS REQUIRED, ADDITIONAL TEMPORARY WORKSPACE WILL BE NECESSARY AT MAJOR ROAD, RAIL, RIVER CROSSINGS, SIDESLOPES, WHERE FULL RIGHT-OF-WAY TOPSOIL STRIPPING IS CONDUCTED AND OTHER SPECIAL CIRCUMSTANCES.
- 2. TOPSOIL IS TO BE STRIPPED OVER THE DITCH AND SPOIL SIDE EXCEPT AS NOTED BELOW.
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- 4. TOPSOIL IS TO BE SEGREGATED AND STOCKPILED ON THE OUTSIDE EDGE OF THE RIGHT-OF-WAY.
- 5. GRADE TO BE RESTORED AFTER CONSTRUCTION

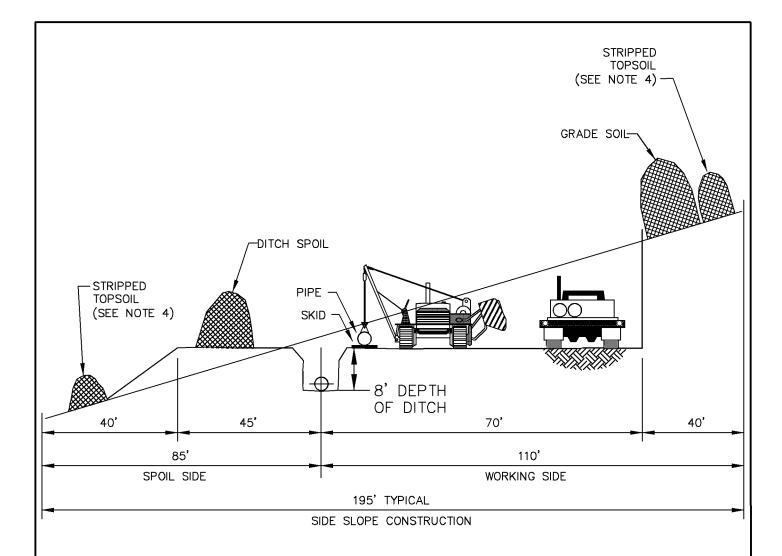

# CROSS-SECTION OF PIPELINE CONSTRUCTION RIGHT-OF-WAY SIDE CUT RIGHT


- 1. CONSTRUCTION RIGHT-OF-WAY WILL TYPICALLY BE 115 FEET WIDE. THE PERMANENT RIGHT-OF-WAY WILL BE 50 FEET WIDE CENTERED ON PIPE. AS REQUIRED, ADDITIONAL TEMPORARY WORKSPACE WILL BE NECESSARY AT MAJOR ROAD, RAIL, RIVER CROSSINGS, SIDESLOPES, WHERE FULL RIGHT-OF-WAY TOPSOIL STRIPPING IS CONDUCTED AND OTHER SPECIAL CIRCUMSTANCES.
- 2. TOPSOIL IS TO BE STRIPPED OVER THE DITCH AND SPOIL SIDE EXCEPT AS NOTED BELOW.
- 3. TOPSOIL IS TO BE STRIPPED ACROSS THE ENTIRE RIGHT-OF-WAY WHEN GRADING IS REQUIRED, IN NOXIOUS WEED AREAS, AT LANDOWNER REQUEST AND/OR AS REQUIRED BY THE ENVIRONMENTAL INSPECTOR.
- 4. TOPSOIL IS TO BE SEGREGATED AND STOCKPILED ON THE OUTSIDE EDGE OF THE RIGHT-OF-WAY.
- 5. GRADE TO BE RESTORED AFTER CONSTRUCTION

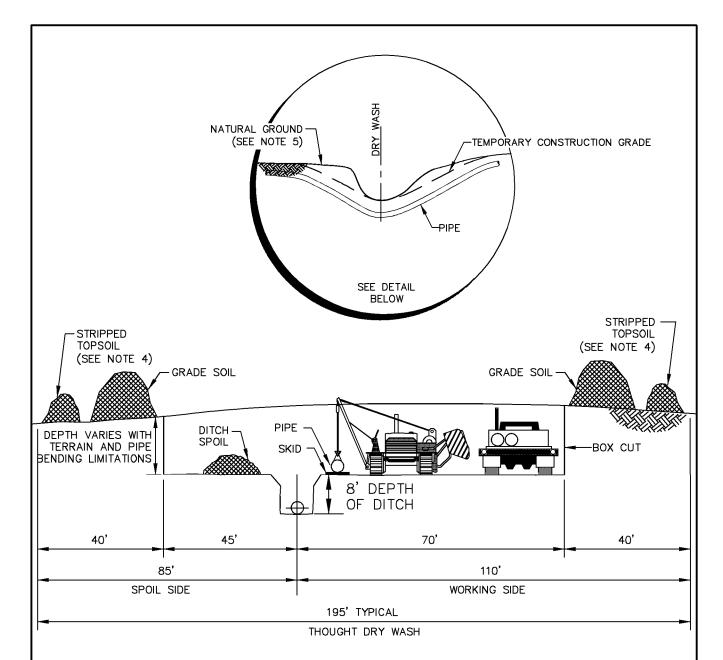

## CROSS-SECTION OF PIPELINE CONSTRUCTION RIGHT-OF-WAY BANKS OF TYPICAL DRY WASH

- 1. CONSTRUCTION RIGHT-OF-WAY WILL TYPICALLY BE 115 FEET WIDE. THE PERMANENT RIGHT-OF-WAY WILL BE 50 FEET WIDE CENTERED ON PIPE. AS REQUIRED, ADDITIONAL TEMPORARY WORKSPACE WILL BE NECESSARY AT MAJOR ROAD, RAIL, RIVER CROSSINGS, SIDESLOPES, WHERE FULL RIGHT-OF-WAY TOPSOIL STRIPPING IS CONDUCTED AND OTHER SPECIAL CIRCUMSTANCES.
- 2. TOPSOIL IS TO BE STRIPPED OVER THE DITCH AND SPOIL SIDE EXCEPT AS NOTED BELOW.
- 3. TOPSOIL IS TO BE STRIPPED ACROSS THE ENTIRE RIGHT-OF-WAY WHEN GRADING IS REQUIRED, IN NOXIOUS WEED AREAS, AT LANDOWNER REQUEST AND/OR AS REQUIRED BY THE ENVIRONMENTAL INSPECTOR.
- 4. TOPSOIL IS TO BE SEGREGATED AND STOCKPILED ON THE OUTSIDE EDGE OF THE RIGHT-OF-WAY.
- 5. BANK OF DRY WASH TO BE RESTORED AFTER CONSTRUCTION
- 6. PIPE TO BE INSTALLED 5' TO 6' BELOW DRY WASH BOTTOM




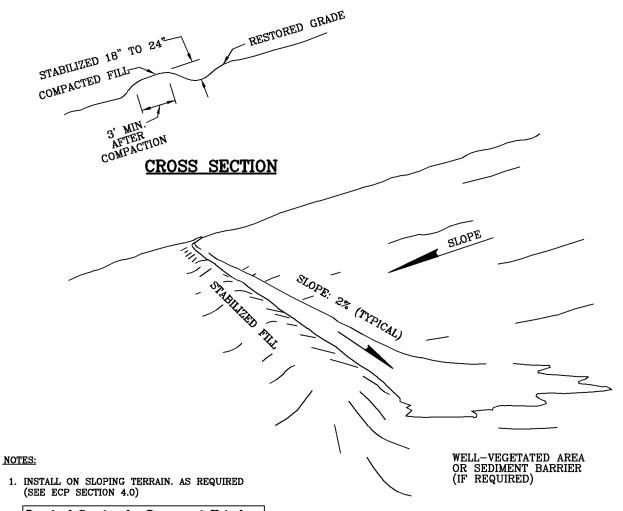

Required Spacing for I	Permanent Waterbars
Slope Percent	Spacing (Ft.)
5 - 15	300
15 - 30	200
> 30	100

- 2. MAINTAIN THROUGHOUT CONSTRUCTION AND REPAIR AT THE END OF EACH DAY.
- 3. OUTLET INTO AREAS STABILIZED BY EXISTING VEGETATION OR INSTALL STAKED STRAW BALES/SILT FENCE.
- 4. CONTOUR TO ALLOW PASSAGE OF CONSTRUCTION EQUIPMENT
- 5. MINIMUM 2% LATERAL SLOPE.
- 6. TEMPORARY WATER BARS/TERRACES MUST BE DESIGNED TO PREVENT WATER FROM ENTERING THE TRENCH. A SOFT/HARD PLUG MAY BE USED TO ALLOW A CONTINUOUS WATER BAR/TERRACE TO CROSS THE TRENCHLINE.


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DRAWING APPROVAL PERMANENT WATER BAF	5
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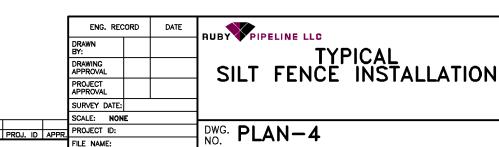
#### NOTES:

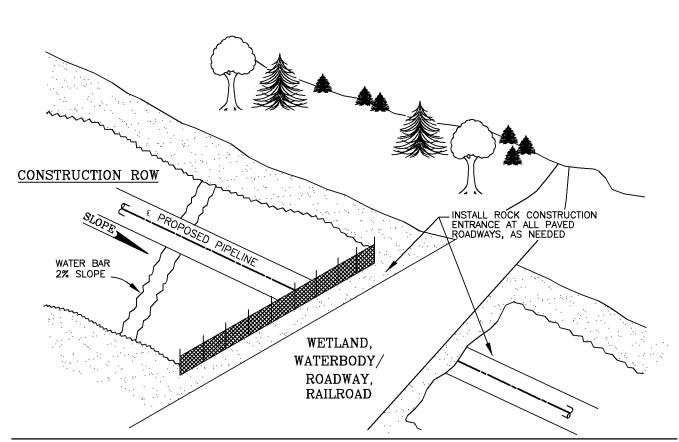
- 1. Silt fence must be left in place until vegetation has been established.
- 2. If paved roadway is used for vehicle access, install rock construction entrance (Figure 4-9).
- 3. Install permanent waterbars upslope of all roadway, railroad, waterbody, and wetland crossings, as required.
- 4. Install permanent trench breakers as required.

DESCRIPTION




- 5. Filter fabric fence must be installed at existing level grade.
- 6. Sediment must be removed where accumulations reach 1/2 the above ground height of the fence.

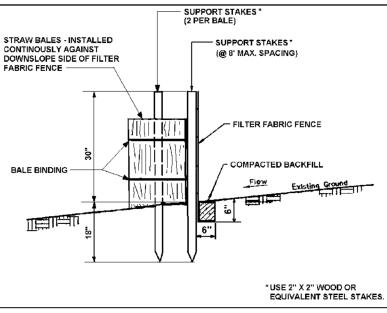


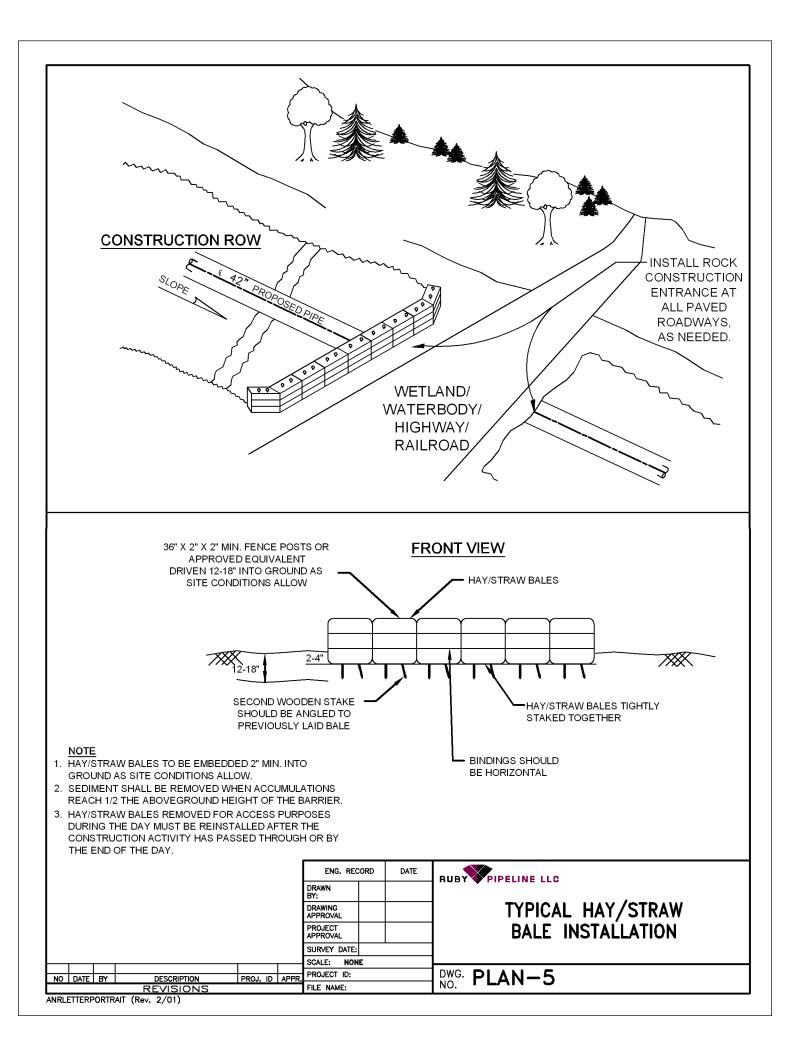

#### SIDE VIEW CROSS SECTION

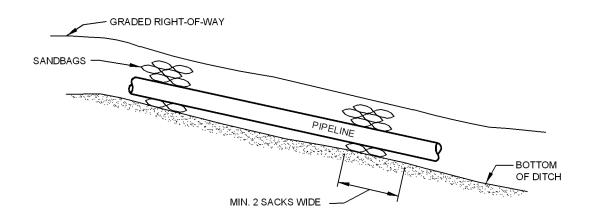

#### **END VIEW CROSS SECTION**

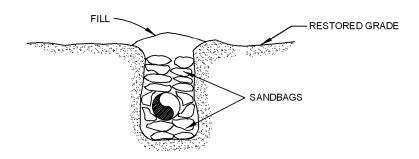


#### NOTE

- CONSTRUCT ON SLOPING TERRAIN AND ADJACENT TO ALL WATERBODIES AND WETLANDS, AS REQUIRED (SEE TABLE BELOW).
- PRIOR TO LOWERING IN PIPE REMOVE ALL DECOMPOSABLE MATERIAL AND LARGE ROCKS.
- BREAKERS MAY BE COMPOSED OF SANDBAGS OR OTHER APPROVED MATERIAL.
- MINIMUM 12 INCHES COVER OVER SANDBAGS IN ALL CASES AND MUST BE A MINIMUM OF 2 SACKS WIDE.
- 5. TOPSOIL SHALL NOT BE USED TO FILL SACKS.


Required Spacing for	r Trench Plugs
Slope Percent	FERC's Spacing (Ft.)
5 - 15	300
15 - 30	200
> 30	100

					ENG. REC	ENG. RECORD		RUBY PIPELINE LLC
					DRAWN BY:			·
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					PROJECT APPROVAL			TRENCH BREAKERS
l					SURVEY DATE:			
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HO	DATE	BY	DESCRIPTION	PROJ. ID APP	PROJECT ID:			DWG. PLAN-6
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#### SIDE VIEW CROSS SECTION

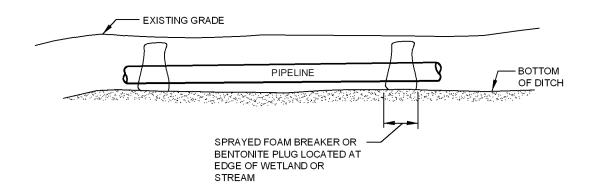


#### **END VIEW CROSS SECTION**

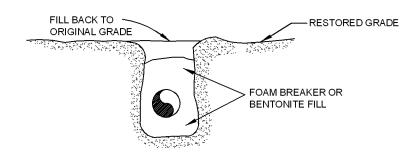


#### NOTE

- CONSTRUCT BREAKERS ADJACENT TO ALL WATERBODIES AND WETLANDS, AS REQUIRED
- 2. PRIOR TO LOWERING IN PIPE REMOVE ALL DECOMPOSABLE MATERIAL AND LARGE ROCKS.

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					DRAWN BY:			•		
					DRAWING APPROVAL			TYPICAL		
					PROJECT APPROVAL			TRENCH BREAKERS AT WETLANDS		
					SURVEY DATE:					
					SCALE: NONE					
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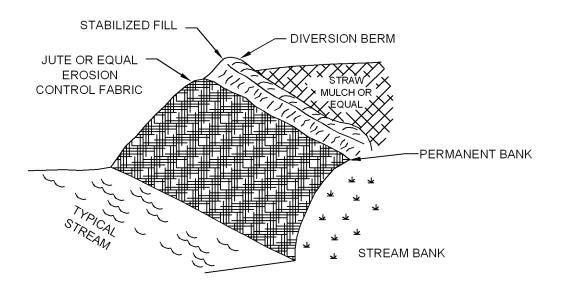


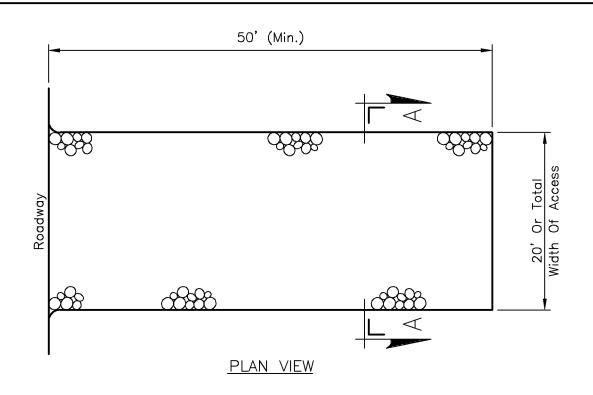
#### NOTE:

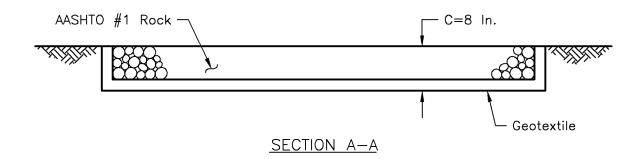Install at intersection of public, paved roadway, and construction right-of-way. Rock Construction Entrance thickness shall be constantly maintained to the specified dimensions by adding rock. A stockpile shall be maintained on site for this purpose. At the end of each construction day, all sediment deposited on paved roadways shall be removed and returned to the construction site. Washing roadway is not permitted. Culverts or flume pipes must be installed under the rock entrance/exit to allow for water drainage, if required due to topographical conditions.

1									
						ENG. REG	ENG. RECORD		RUBY PIPELINE LLC
						DRAWN BY:			·
						DRAWING APPROVAL			TYPICAL ROCK CONSTRUCTION ENTRANCE
						PROJECT APPROVAL			CONSTRUCTION ENTRANCE
l						SURVEY DATE:			
$\vdash$	_					SCALE:			
H <sub>NO</sub>	DATE	By		DESCRIPTION	PROJ. ID APP	PROJECT ID:			DWG. PLAN-7
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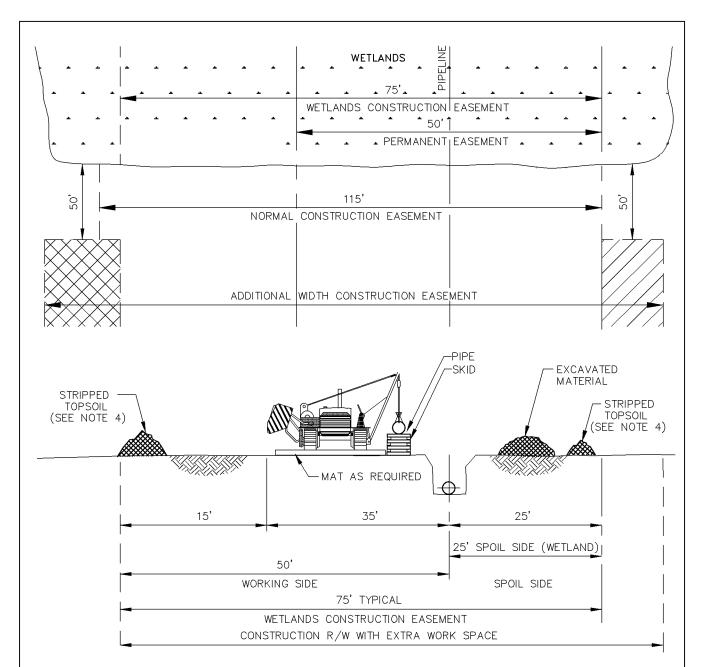
#### STAKE TO THE SLOPE WITH WOOD PEGS OR STAPLE PER MANUFACTURER'S SPECIFICATION



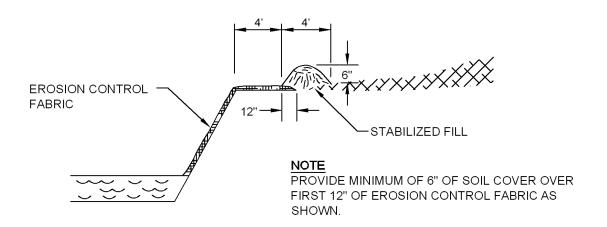

#### **SLOPE SECTION**


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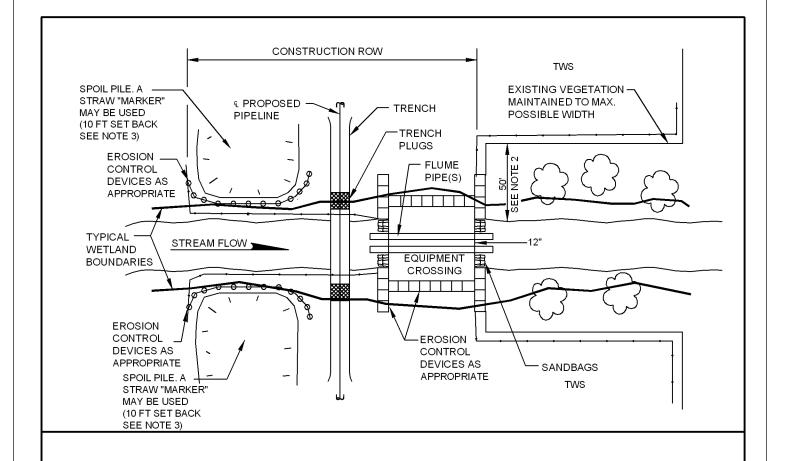


## CROSS-SECTION OF PIPELINE CONSTRUCTION RIGHT-OF-WAY CROSSING WETLAND AREAS


- 1. WETLANDS CONSTRUCTION RIGHT-OF-WAY WILL BE LIMITED TO 75 FEET WIDE ACROSS ANY WETLANDS UNLESS INCREASED OR DECREASED BY SPECIFIC CONSTRUCTION REQUIREMENTS. PERMANENT RIGHT-OF-WAY WILL BE 50 FEET WIDE CENTERED ON PIPE.
- 2. THE 115 FOOT NORMAL CONSTRUCTION RIGHT-OF-WAY EXTENDS TO THE EDGE OF THE WETLAND BOUNDARY. ADDITIONAL WIDTH CONSTRUCTION RIGHT-OF-WAY IF SPECIFIED BEGINS AND ENDS 50 FEET FROM EACH SIDE OF THE WETLAND BOUNDARY.
- 3. STOCKPILE TOPSOIL ON OUTSIDE EDGE OF RIGHT-OF-WAY IF GRADING OF RIGHT-OF-WAY IS REQUIRED OR REQUIRED BY THE ENVIRONMENTAL INSPECTOR, SNOW MAY ALSO BE PLACED IN THIS AREA.
- 4. STOCKPILE TOPSOIL ON OUTSIDE EDGE OF RIGHT-OF-WAY IF GRADING OF RIGHT-OF-WAY IS REQUIRED OR WITH PERMISSION OF ENVIRONMENTAL INSPECTOR.






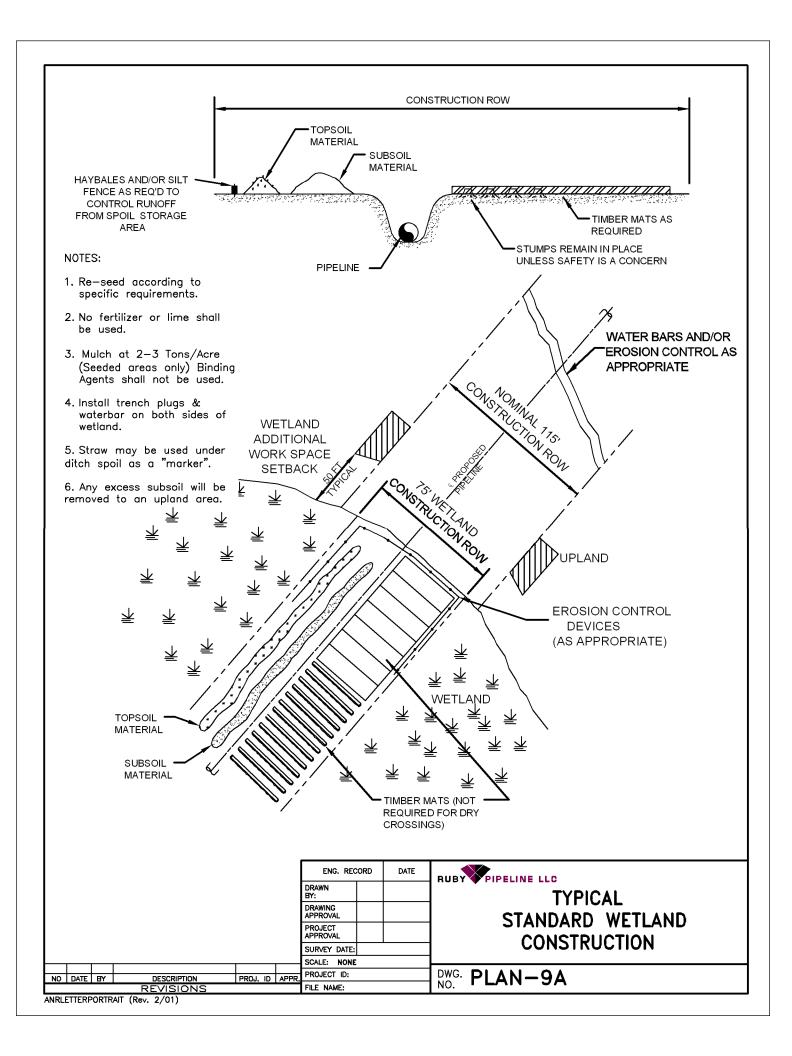


#### CROSS SECTION FOR EQUIPMENT CROSSING

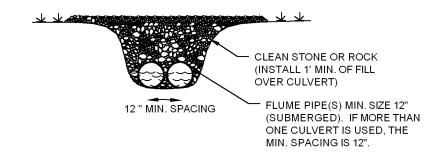


- 1. PORTABLE BRIDGES OR MATS MAY BE USED FOR EQUIPMENT CROSSING IF CONTOURS ALLOW.
- THE REQUIRED SETBACK FOR ADDITIONAL WIDTH WORK SPACE IS 50 FEET FROM TOP OF BANK UNLESS APPROVED OTHERWISE BY THE APPROPRIATE AGENCIES.
- 3. THE MINIMUM REQUIRED SETBACK FOR SPOIL PILE IS 10 FEET FROM THE TOP OF BANK.
- 4. EQUIPMENT BRIDGE TO REMAIN IN PLACE UNTIL THE COMPLETION OF FINAL RESTORATION.
- 5. WEED-FREE STRAW BALES, SAND BAGS, DRIVABLE BERMS OR OTHER APPROPRIATE EROSION CONTROL MAY BE USED INTERCHANGEABLY AT THE EDGE OF EQUIPMENT BRIDGE.
- 6. A LAYER OF STRAW MAY BE USED AS A "MARKER" BETWEEN SPOIL AND WETLAND SOIL.

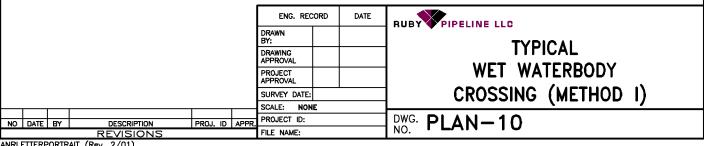


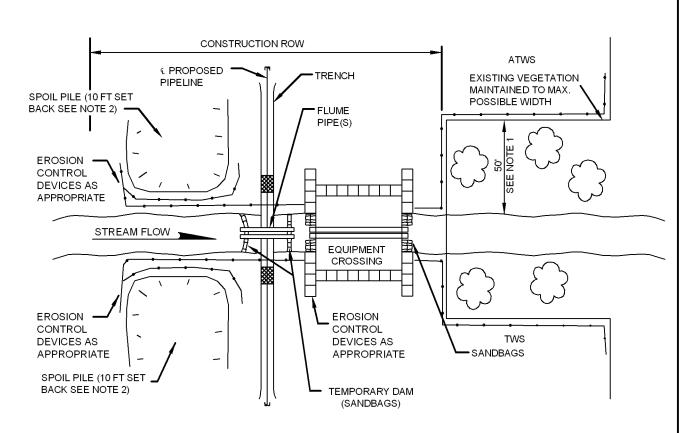




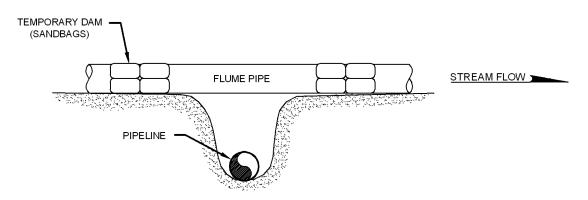


- 1. THE REQUIRED SET BACK FOR ADDITIONAL WIDTH WORK SPACE IS 50 FEET FROM TOP OF BANK UNLESS APPROVED OTHERWISE BY THE APPROPRIATE AGENCIES.
- 2. A 10' VEGETATION BUFFER WILL BE MAINTAINED BETWEEN THE BANK AND TWS.
- 3. THE MINIMUM REQUIRED SETBACK FOR SPOIL PILE IS 10 FEET FROM THE TOP OF BANK.
- 4. EQUIPMENT BRIDGE SHALL REMAIN IN PLACE UNTIL THE COMPLETION OF FINAL RESTORATION.
- 5. WEED-FREE STRAW BALES, SAND BAGS, DRIVABLE BERMS OR OTHER APPROPRIATE EROSION CONTROL MAY BE USED INTERCHANGEABLY AT THE EDGE OF EQUIPMENT BRIDGE.

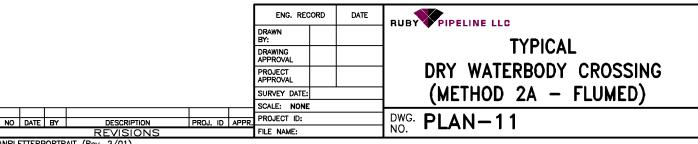

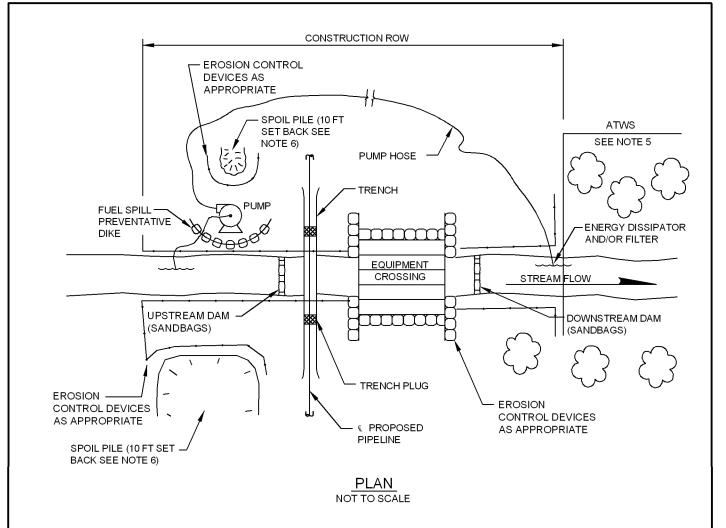


- 1. SET UP PUMP AND HOSE AS SHOWN, OR USE OTHER PRACTICAL ALTERNATIVES. PUMP SHOULD HAVE TWICE THE PUMPING CAPACITY OF ANTICIPATED FLOW.
- 2. CONTRACTOR TO ENSURE A SUFFICIENT NUMBER OF ACTIVE AND BACKUP PUMPS TO MAINTAIN THE CAPACITY OF THE STREAM FLOW AT ALL TIMES DURING INSTALLATION.
- 3. ALL INTAKE HOSES WILL BE SCREENED.
- 4. DISMANTLE DOWNSTREAM DAM, THEN UPSTREAM DAM. KEEP PUMP RUNNING TO MAINTAIN STREAM FLOW.
- THE REQUIRED SET BACK FOR ADDITIONAL WIDTH WORK SPACE IS 50 FEET FROM TOP OF BANK UNLESS APPROVED OTHERWISE BY THE APPROPRIATE AGENCIES.
- 6. A 10' VEGETATION BUFFER WILL BE MAINTAINED BETWEEN THE BANK AND TWS.
- 7. THE MINIMUM REQUIRED SETBACK FOR SPOIL PILE IS 10 FEET FROM THE TOP OF BANK.
- 8. WEED-FREE STRAW BALES, SAND BAGS, DRIVABLE BERMS OR OTHER APPROPRIATE EROSION CONTROL MAY BE USED INTERCHANGEABLY AT THE EDGE OF EQUIPMENT BRIDGE.


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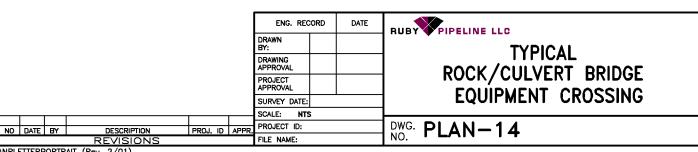
#### TIMBER MAT AND ROCK/CULVERT BRIDGE

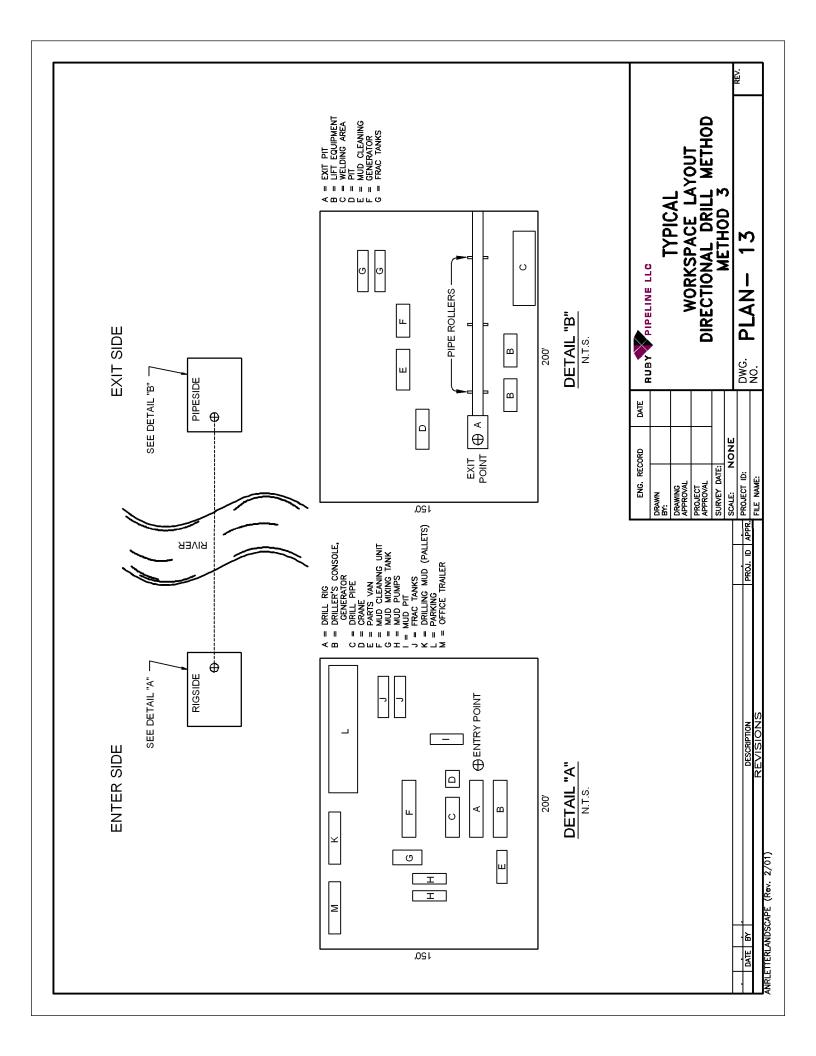




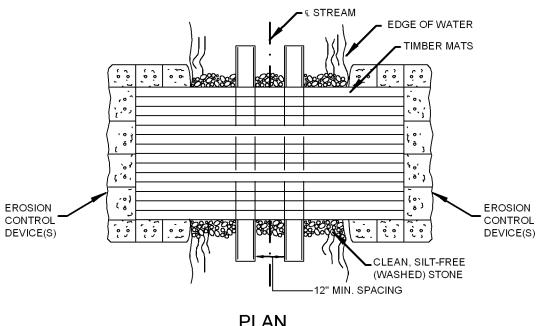

- 1. THIS TYPE OF BRIDGE IS GENERALLY USED FOR MEDIUM-SIZED STREAM CROSSINGS.
- 2. THE NUMBER AND SIZE OF THE FLUME PIPES WILL BE DESIGNED TO HANDLE MAXIMUM EXPECTED FLOW OF STREAM AT TIME OF CONSTRUCTION. MIN. SIZE CULVERT WILL BE 12".
- 3. CLEAN, SILT-FREE ROCK TO BE USED ONLY. INSTALL 12" MIN. OF FILL OVER CULVERT.
- 4. BRIDGE TO REMAIN IN PLACE UNTIL THE COMPLETION OF FINAL RESTORATION.
- 5. SILT FENCE, WEED-FREE STRAW BALES, SANDBAGS, DRIVABLE BERMS OR OTHER APPROPRIATE EROSION CONTROL MAY BE USED INTERCHANGEABLY.
- 6. STRAW BALES WILL BE PLACED AT THE EDGE OF EQUIPMENT BRIDGE AT THE END OF THE WORK DAY TO PREVENT EROSION BUT WILL BE REMOVED DURING CONSTRUCTION ACTIVITY.

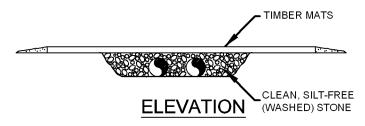


#### TIMBER MAT BRIDGE

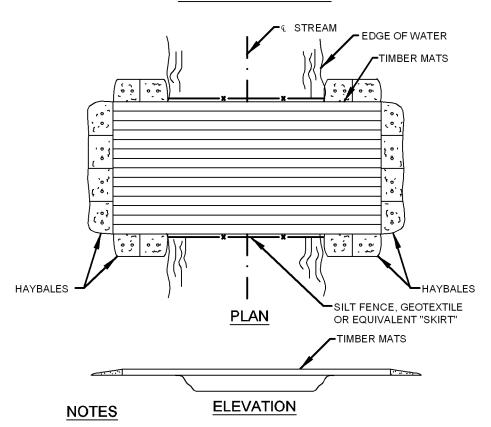

- THIS TYPE OF BRIDGE IS GENERALLY USED FOR SMALL STREAM CROSSINGS LESS THAN 20 FEET IN WIDTH IN COMBINATION WITH A PROPER STREAM BANK CONFIGURATION.
- 2. BRIDGE WILL BE TEMPORARILY REMOVED IF HIGH WATER RENDERS IT UNSAFE FOR CROSSING.
- 3. BRIDGE TO REMAIN IN PLACE UNTIL THE COMPLETION OF FINAL RESTORATION.
- 4. SILT FENCE, WEED FREE STRAW BALES, SAND BAGS, DRIVABLE BERMS OR OTHER APPROPRIATE EROSION CONTROL MAY BE USED INTERCHANGEABLY.
- 5. A "SKIRT" FORMED OF SILT FENCE, GEOTEXTILE FABRIC OR EQUIVALENT SHALL BE PLACED ON THE SIDES AND BOTTOM OF THE BRIDGE TO TRAP SEDIMENT AS NECESSARY.
- INDIVIDUAL MATS SHALL BE ANCHORED AND BUTTED TIGHTLY TO MINIMIZE THE INTRODUCTION OF SEDIMENT TO THE WATERBODY.
- 7. STRAW BALES OR APPROPRIATE BARRIER WILL BE PLACED AT THE EDGE.

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#### **ROCK/CULVERT BRIDGE**



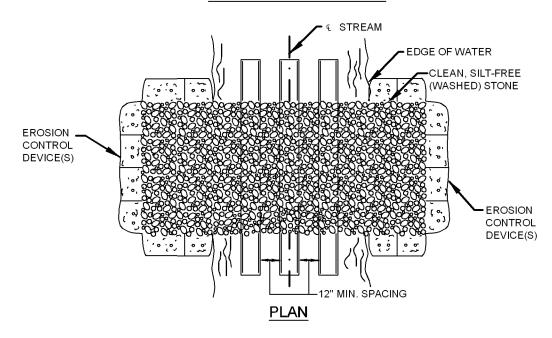

#### **ELEVATION**

#### **NOTES**

- THIS TYPE OF BRIDGE IS USED ON MEDIUM TO LARGE STREAMS WITH POTENTIAL FOR SIGNIFICANT FLOW.
- 2. THE NUMBER AND SIZE OF FLUME PIPES WILL BE DESIGNED TO HANDLE THE MAXIMUM EXPECTED FLOW OF THE STREAM AT TIME OF CONSTRUCTION. MIN. SIZE CULVERT WILL BE 12".
- CLEAN, SILT-FREE ROCK TO BE USED ONLY. INSTALL 1" MIN. OF FILL OVER CULVERT.
- BRIDGE TO REMAIN IN PLACE UNTIL THE COMPLETION OF FINAL RESTORATION.
- SILT FENCE, WEED-FREE STRAW BALES, SANDBAGS, DRIVABLE BERMS OR OTHER APPROPRIATE EROSION CONTROL MAY BE USED INTERCHANGEABLY.
- ROCK MUST EXTEND 10' FROM TOP OF BANK ON BOTH SIDES OF WATERWAY.
- STRAW BALES WILL BE PLACED AT THE EDGE OF EQUIPMENT BRIDGE AT THE END OF THE WORK DAY TO PREVENT EROSION BUT WILL BE REMOVED DURING CONSTRUCTION ACTIVITY.

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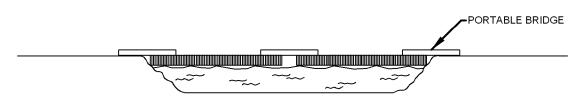
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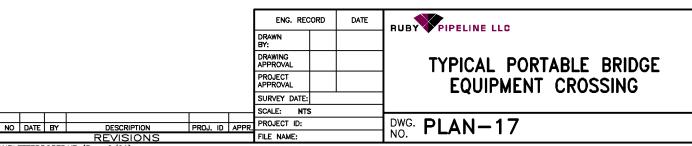
# PORTABLE BRIDGE STREAM EDGE OF WATER PORTABLE BRIDGE CONTROL DEVICE(S) PLAN





#### **ELEVATION**

#### NOTES

- THIS TYPE OF BRIDGE IS GENERALLY USED ON WIDE, DEEP CROSSINGS.
- 2. BRIDGE IS ANCHORED AND/OR TIED OFF TO ANCHOR BLOCKS FOR STABILITY.
- 3. BRIDGE TO REMAIN IN PLACE UNTIL THE COMPLETION OF FINAL RESTORATION.
- 4. SILT FENCE, WEED-FREE STRAW BALES, SANDBAGS, DRIVABLE BERMS OR OTHER APPROPRIATE EROSION CONTROL MAY BE USED INTERCHANGEABLY.
- 5. STRAW BALES WILL BE PLACED AT THE EDGE OF EQUIPMENT BRIDGE AT THE END OF THE WORK DAY TO PREVENT EROSION BUT WILL BE REMOVED DURING CONSTRUCTION ACTIVITY.



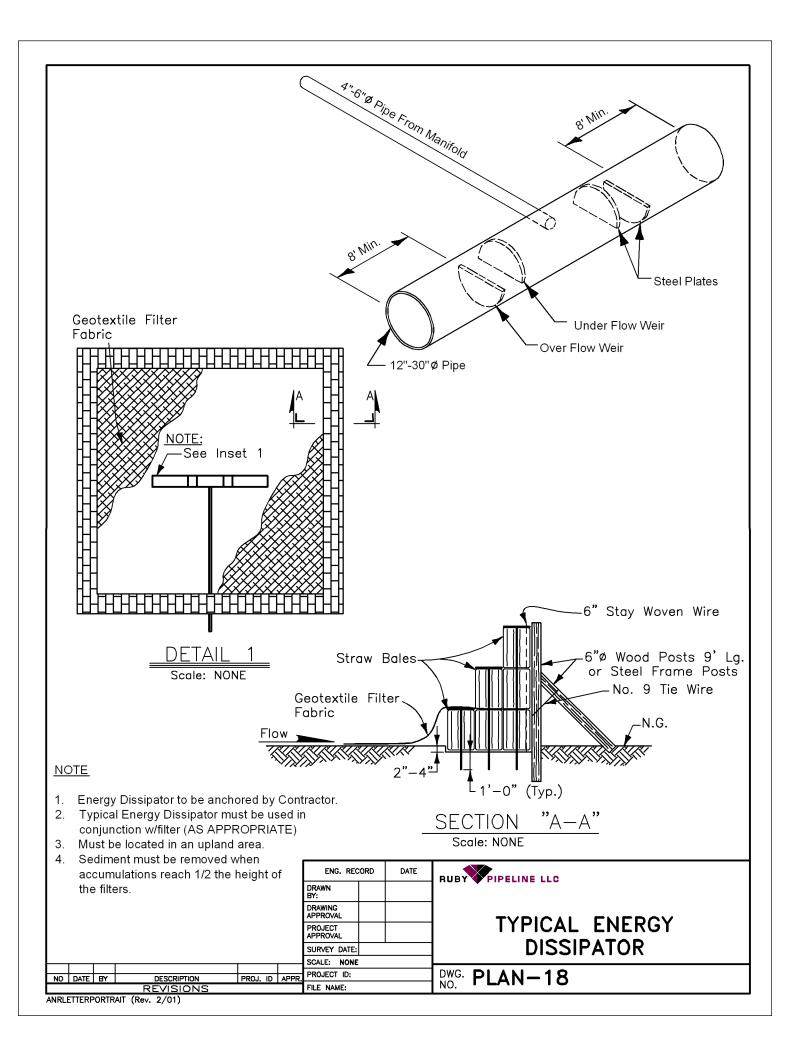


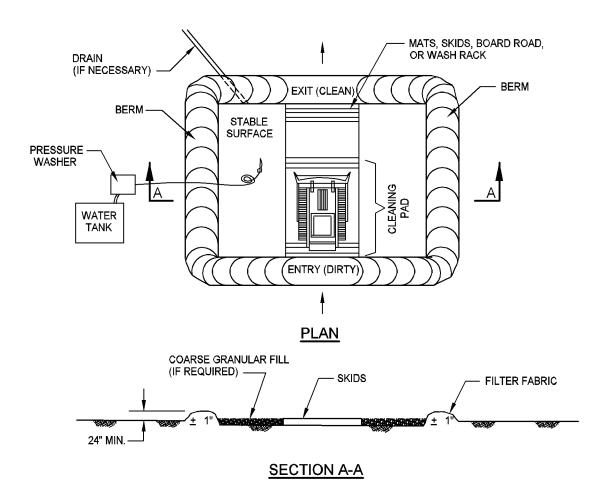


ALL EQUIPMENT SHALL ARRIVE TO THE PROJECT CLEAN OR BE WASHED PRIOR TO MOBILIZATION TO THE ROW.

#### NOTES:


- 1. ALL EQUIPMENT AND VEHICLES SHALL BE REQUIRED TO BE WASHED AT WASH STATIONS AS SHOWN ON THE CONSTRUCTION DRAWINGS OR AS DIRECTED IN THE NOXIOUS WEED MANAGEMENT PLAN. WASH STATIONS SHALL BE CONSTRUCTED BY THE CONTRACTOR. WASHINGS SHALL BE CARRIED OUT UNDER THE SUPERVISION AND TO THE SATISFACTION OF THE COMPANY REPRESENTATIVE.
- 2. TOP SOIL TO BE SEGREGATED AND STORED SEPARATELY.
- 3. WASH WATER USED FOR CLEANING SHALL NOT BE ALLOWED TO ENTER ANY WATERBODY, WETLAND, OR IRRIGATION CANAL/DITCH. ANY SOILS CONTAMINATED BY PETROLEUM -BASED OR OTHER UNDESIRABLE MATERIALS FROM WASH STATIONS SHALL BE REMOVED IN ACCORDANCE WITH APPLICABLE REQUIREMENTS.
- 4. SIZE OF STATION TO BE ADEQUATE TO ACCOMODATE MAXIMUM SIZE OF EQUIPMENT AND REQUIRED FOR WORK.
- 5. EQUIPMENT TO ENTER A "DIRTY END" AND EXIT A "CLEAN END".
- 6. STABLE DRAINAGE FROM SITE (IF NECESSARY) TO BE PROVIDED. DO NOT DISCHARGE TO A STREAM OR WETLAND.
- DISPOSAL OF GRAVEL FILL (IF REQUIRED) AND FILTER FABRIC IS TO BE APPROVED BY ENVIRONMENTAL INSPECTOR.
- 8. WASH STATIONS ARE TO BE EQUIPPED WITH SKID PADS OR WASH RACKS TO PREVENT SOIL FROM BEING CARRIED ON TRACKS OR TIRES AS EQUIPMENT AND VEHICLES EXIT THE WASH STATION.

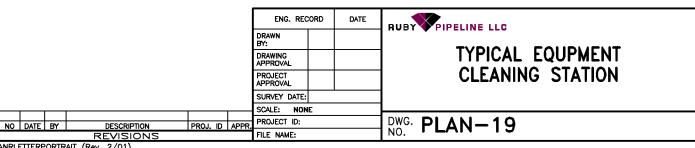

#### TIMBER MAT BRIDGE

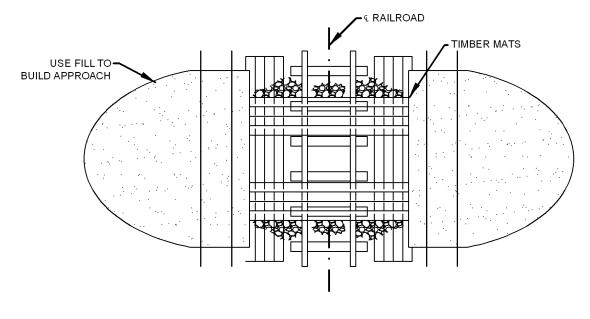

#### **PLAN**

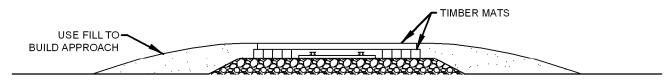

#### **ELEVATION**

#### NOTES

- THIS TYPE OF BRIDGE IS GENERALLY USED FOR ACCESS ACROSS RAILROAD TRACKS
- 2. CONTRACTOR WILL USE DIGGING MATS FOR THE CROSSING. THESE ARE NORMALLY 4' WIDE BY 16' LONG AND 8" TO 10" THICK.

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APPROVAL

SURVEY DATE:

SCALE: NTS

PROJECT ID:

FILE NAME:

RUBY PIPELINE LLC

TYPICAL RAILROAD EQUIPMENT CROSSING

DWG. PLAN-20

ANRLETTERPORTRAIT (Rev. 2/01)

DESCRIPTION

PROJ. ID APP